




WINDOW FLASHING 1 1/2" = 1'-0" 30

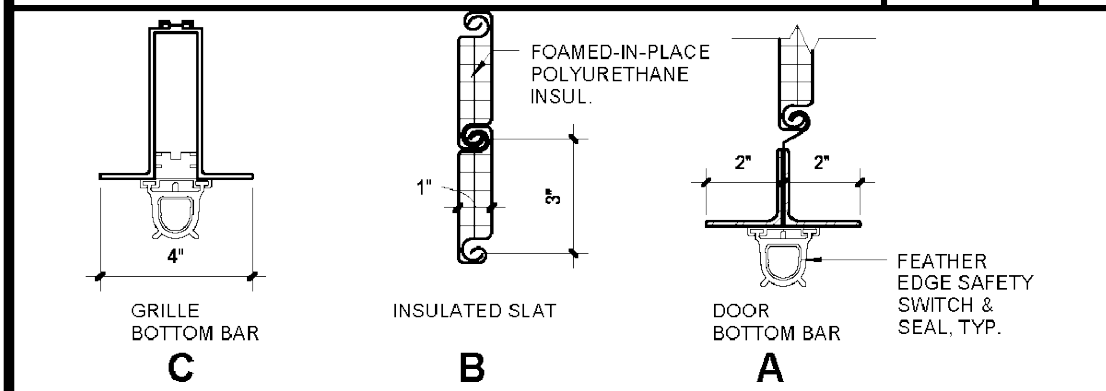


OVERHEAD COILING DOOR DETAILS 3" = 1'-0" 29

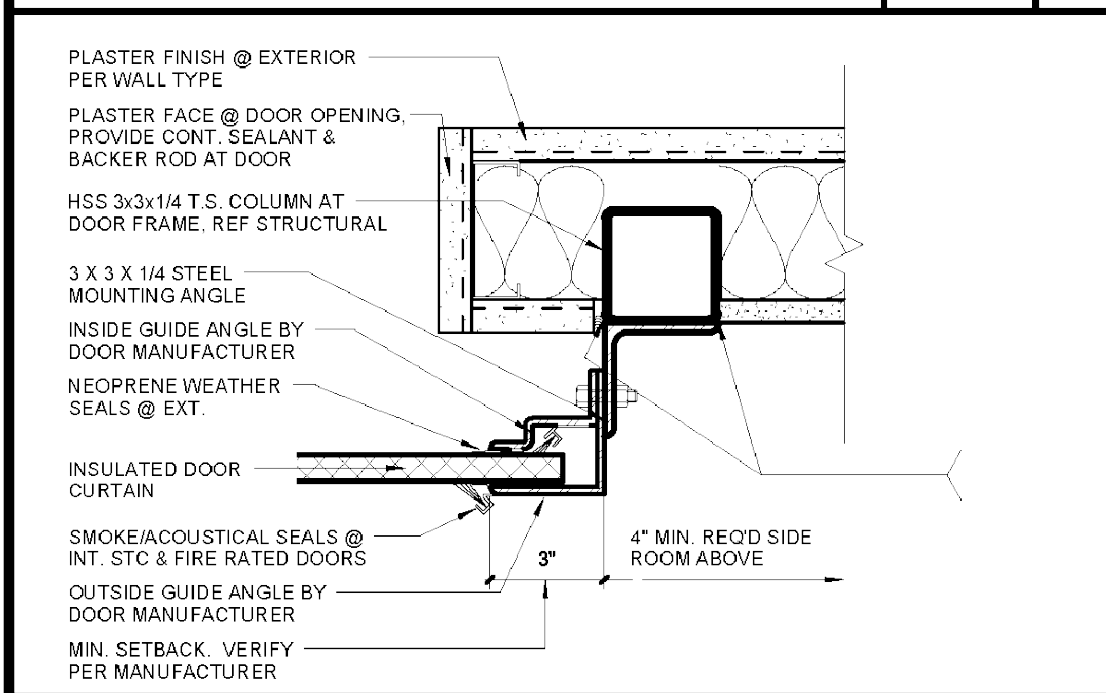

OVERHEAD COILING DOOR JAMB 3" = 1'-0" 28

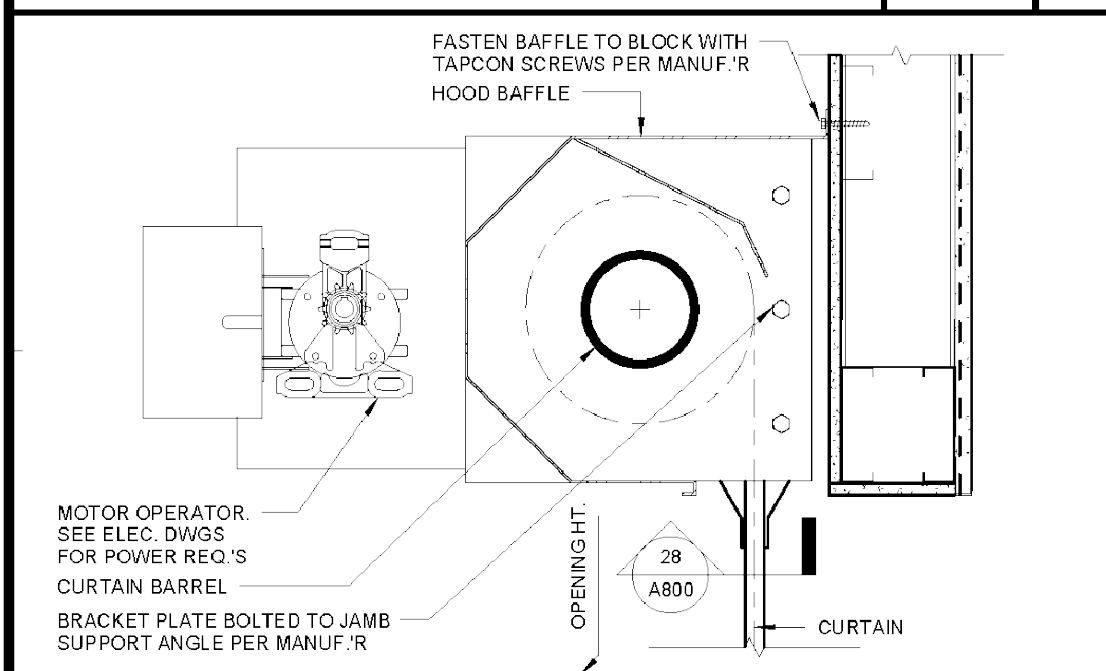

OVERHEAD COILING DOOR HEAD 1 1/2" = 1'-0" 27

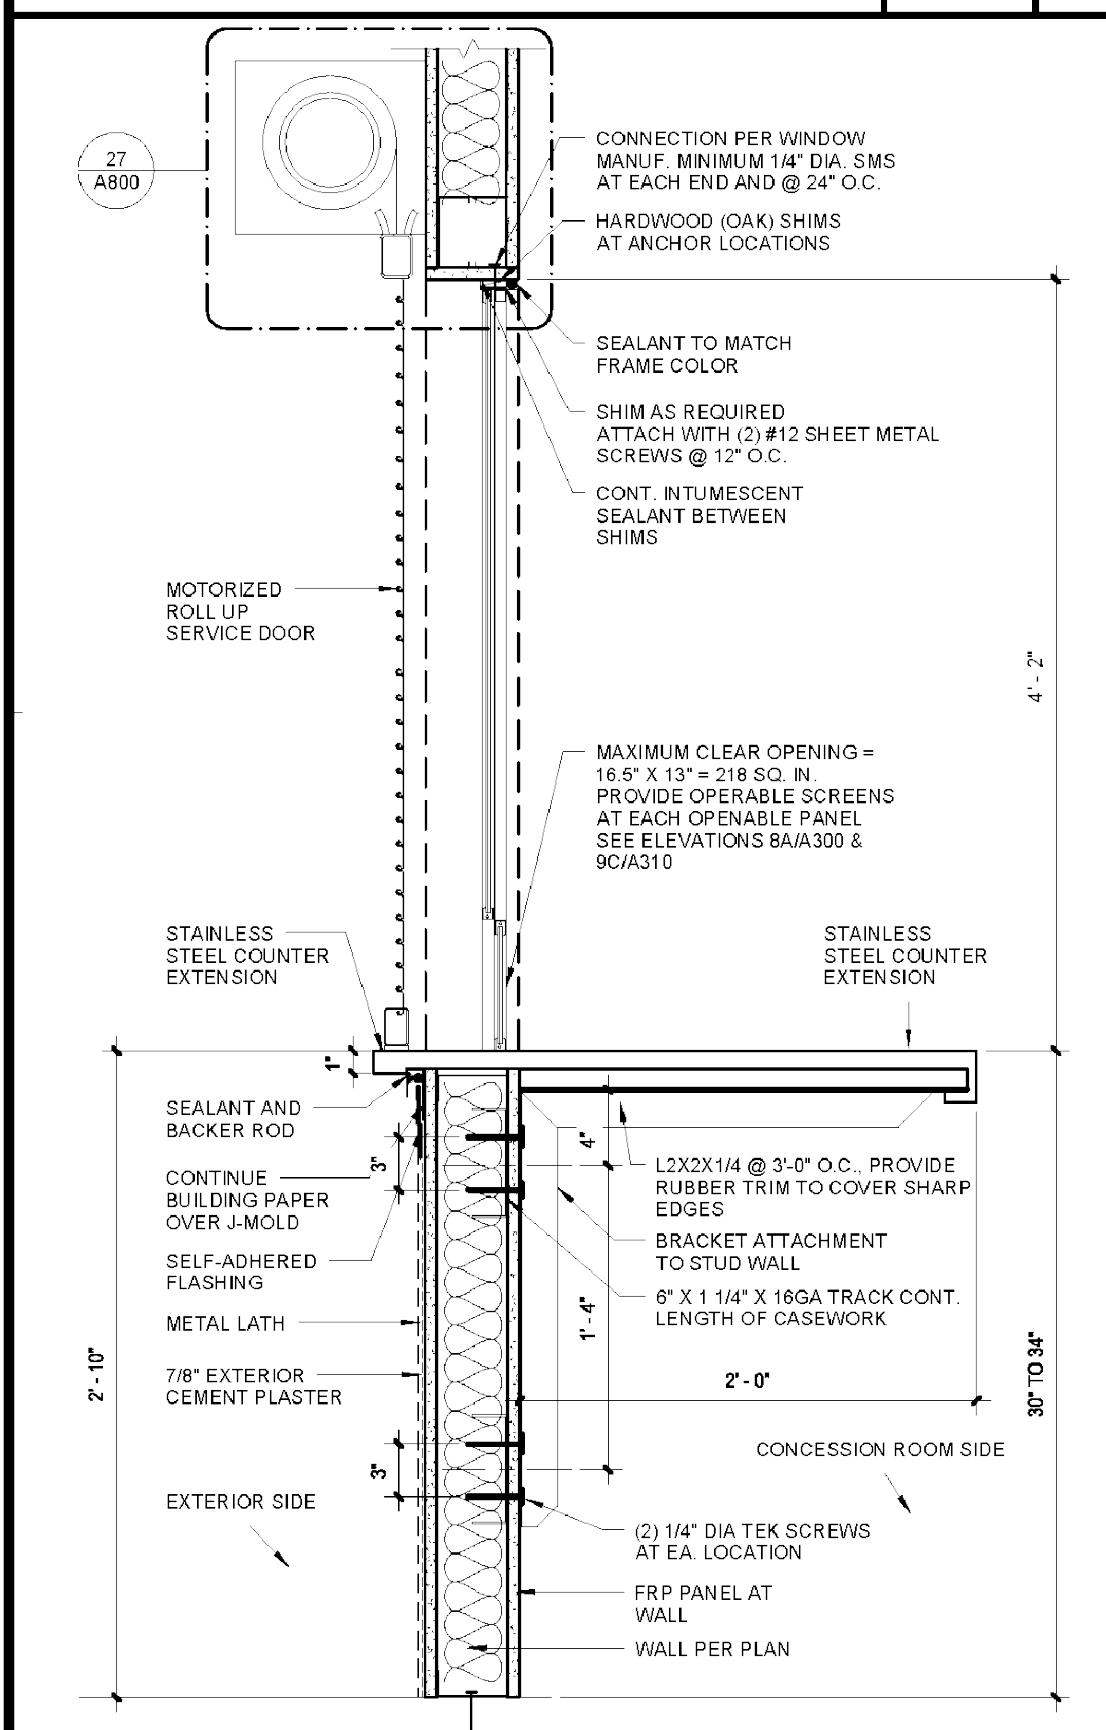

EXT. SERVICE WINDOW 1 1/2" = 1'-0" 25

SCHEDULE						
TYPE	WIDTH	HEIGHT	FIRE RATING	FRAME MATERIAL	FINISH	THICKNESS
W1	2'-6"	3'-0"	-	ALUM	FF	1/4 CLEAR
W2	5'-6"	4'-2"	-	ALUM	FF	1/4 CLEAR
W3	4'-6"	4'-2"	-	ALUM	FF	1/4 CLEAR


VARIES BY SCHEDULE

MAXIMUM CLEAR OPENING = 16'5" X 13' = 218 SQ. IN. PROVIDE OPERABLE SCREENS AT EACH OPENABLE PANEL


FIXED EXTERIOR AT TICKET BOOTH

FIXED EXTERIOR

WINDOW SCHEDULE AND LEGEND

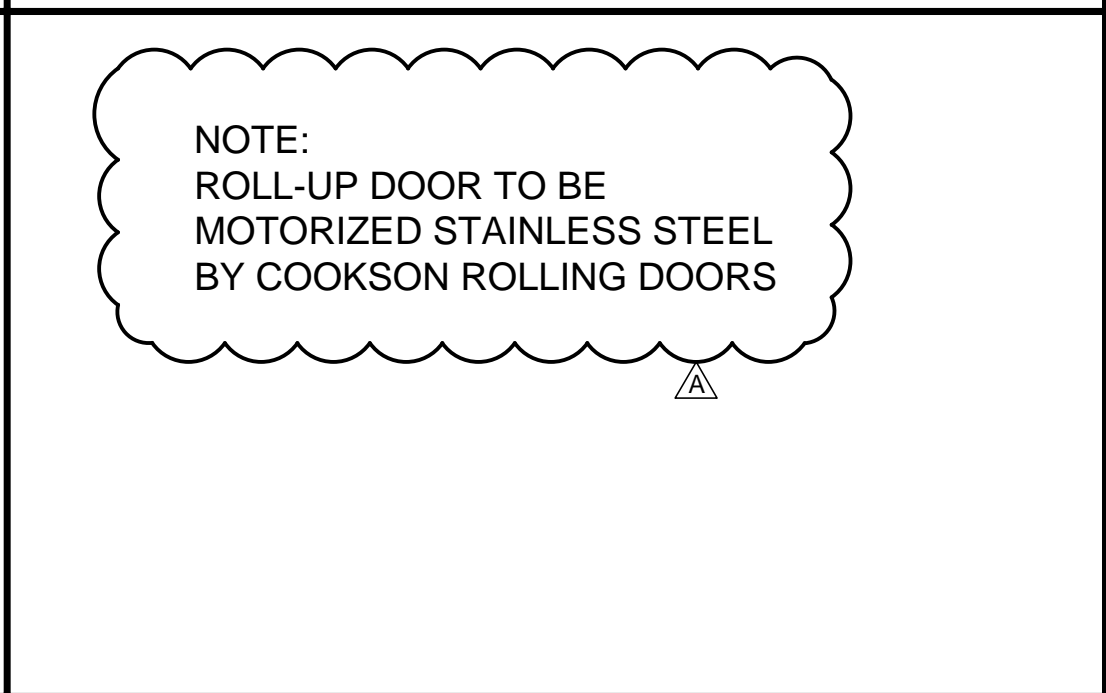


5

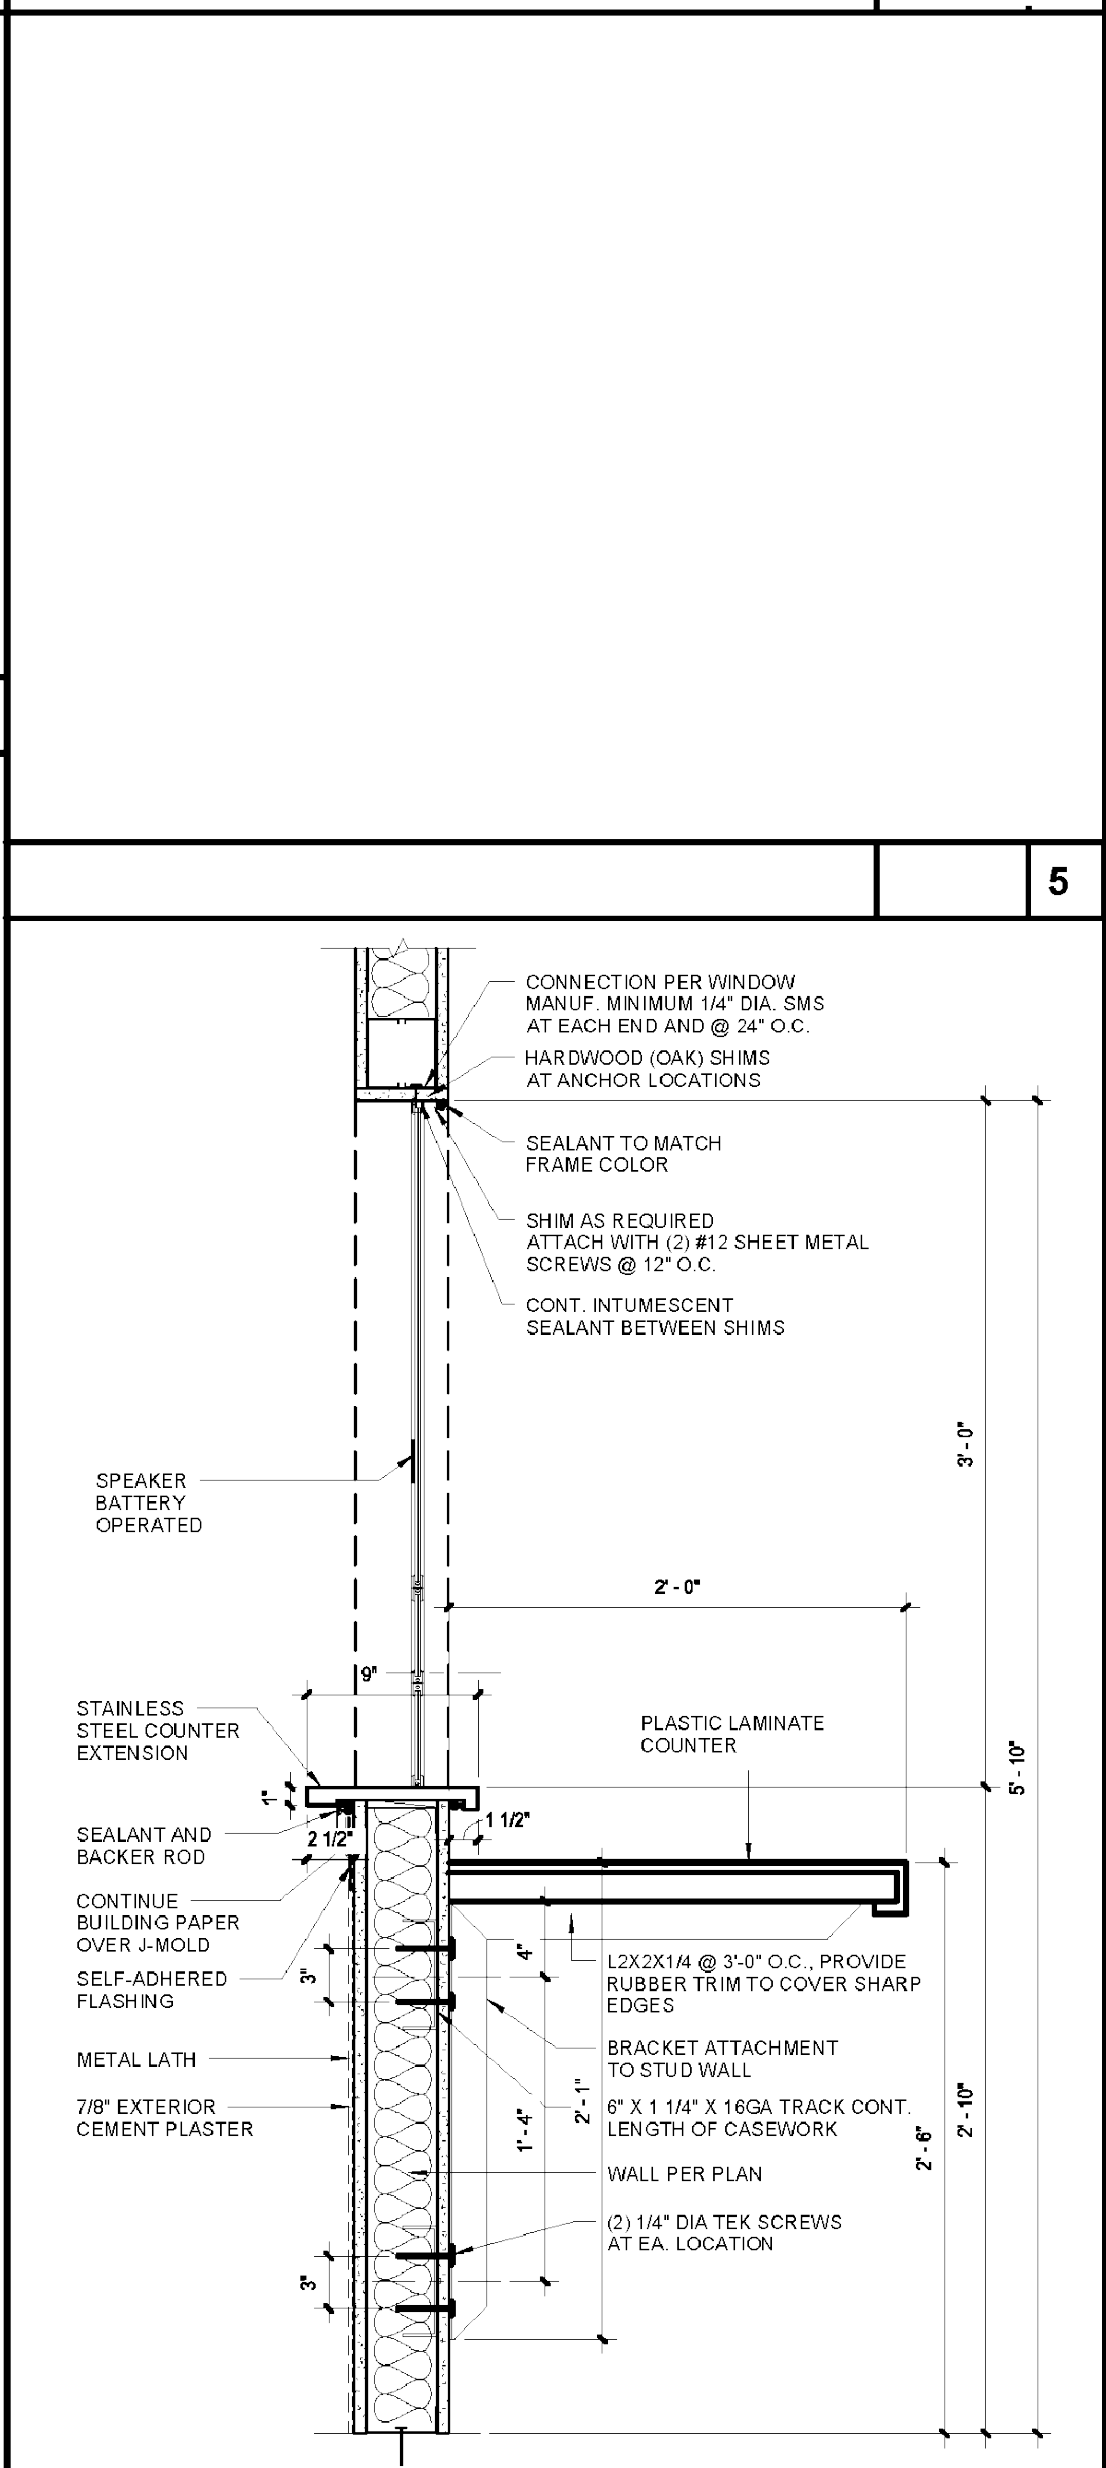

EXT. TICKET BOOTH WINDOW 1 1/2" = 1'-0" 15

Show All											
WT	WIDTH	HEIGHT	TYPE	DOOR MATERIAL	FINISH	FRAME MATERIAL	FINISH	DETAILS THRESHOLD	HARDWARE GROUP	FIRE RATING	REMARKS
MODULAR BUILDING (HOME)											
101	3'-0"	7'-0"	B	HM	FFFP	KD	FFFP	1/A800	1		
102A	3'-0"	7'-0"	B	HM	FFFP	KD	FFFP	1/A800	6		MEN SIGNAGE SEE DETAIL 5/ GEN-4
102B	3'-0"	7'-0"	B	HM	FFFP	KD	FFFP	1/A800	6		MEN SIGNAGE SEE DETAIL 5/ GEN-4
103A	3'-0"	7'-0"	B	HM	FFFP	KD	FFFP	1/A800	6		WOMEN SIGNAGE SEE DETAIL 10/ GEN-4
103B	3'-0"	7'-0"	B	HM	FFFP	KD	FFFP	1/A800	7		WOMEN SIGNAGE SEE DETAIL 10/ GEN-4
104A	3'-0"	7'-0"	B	HM	FFFP	KD	FFFP	1/A800	2		
104B	3'-0"	7'-0"	RLP-1	AL	FFFP	AL	FFFP	-	8		
105A	3'-0"	7'-0"	A	HM	FFFP	KD	FFFP	1/A800	3		
105B	3'-0"	7'-0"	A	HM	FFFP	KD	FFFP	1/A800	4		
105C	4'-6"	4'-4"	RLP-2	AL	AN	AL	AN	-	09		
105D	4'-6"	4'-4"	RLP-2	AL	AN	AL	AN	-	09		
105E	3'-0"	7'-0"	A	HM	FFFP	KD	FFFP	1/A800	3		
106A	3'-0"	7'-0"	A	HM	FFFP	KD	FFFP	1/A800	3		
106B	3'-0"	7'-0"	RLP-1	AL	FFFP	AL	FFFP	-	8		
TICKET BOOTH											
108	3'-0"	7'-0"	A	HM	FFFP	KD	FFFP	1/A800	3		
MODULAR BUILDING (VISITOR)											
201A	3'-0"	7'-0"	B	HM	FFFP	KD	FFFP	1/A800	6		WOMEN SIGNAGE SEE DETAIL 10/ GEN-4
201B	3'-0"	7'-0"	B	HM	FFFP	KD	FFFP	1/A800	7		WOMEN SIGNAGE SEE DETAIL 10/ GEN-4
202A	3'-0"	7'-0"	B	HM	FFFP	KD	FFFP	1/A800	6		MEN SIGNAGE SEE DETAIL 5/ GEN-4
203A	7'-0"	7'-0"	RLP-1	AL	FFFP	AL	FFFP	-	8		
203B	3'-0"	7'-0"	A	HM	FFFP	KD	FFFP	1/A800	2		
204	3'-0"	7'-0"	A	HM	FFFP	KD	FFFP	1/A800	1		
205A	3'-0"	7'-0"	A	HM	FFFP	KD	FFFP	1/A800	08		
205B	5'-6"	4'-2"	RLP-1	AL	AN	AL	AN	-	09		
205C	3'-0"	7'-0"	A	HM	FFFP	KD	FFFP	1/A800	2		
206A	3'-0"	7'-0"	RLP-1	AL	FFFP	AL	FFFP	-	8		
206B	3'-0" 5/16"	7'-0"	A	HM	FFFP	KD	FFFP	1/A800	2		


DOOR TYPES

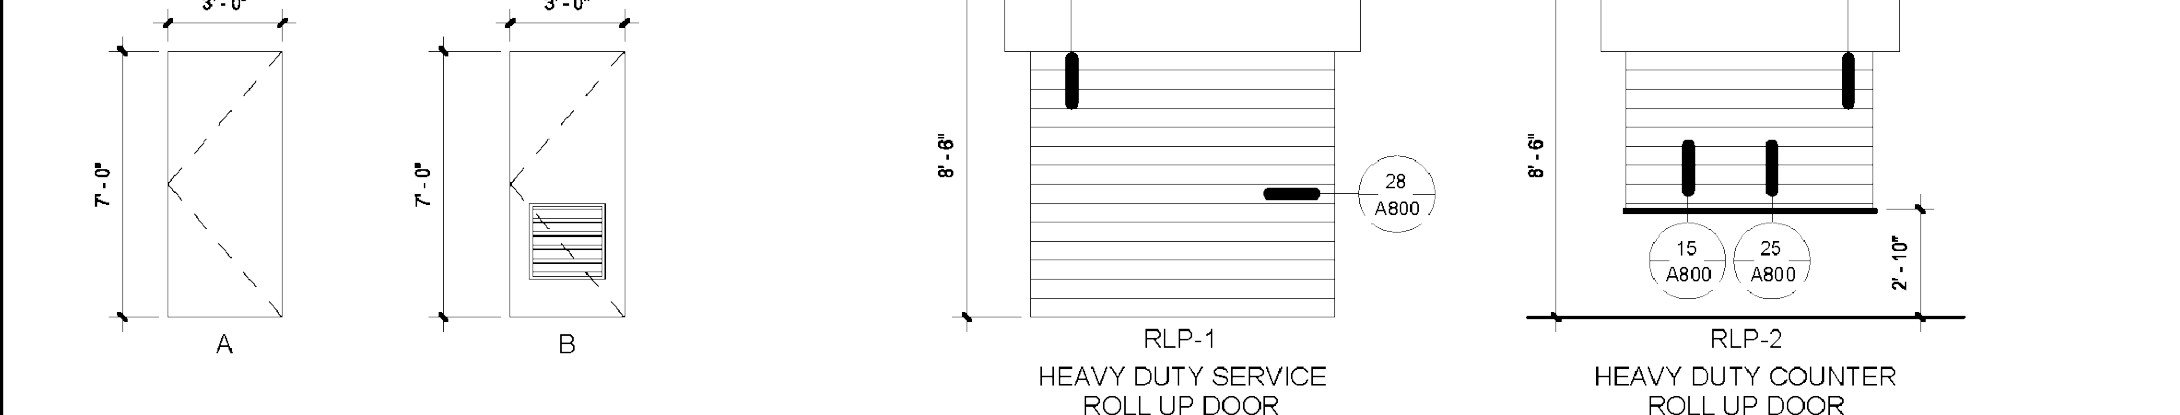


DOOR HARDWARE

Heading 1											
1	EA	HINGE	3CB14.5 X 4.5 NRP	630	IVE						
1	EA	STOREROOM LOCK	L807L D6LL 10-072 7/8" LIP L283-150	630	SCH						
1	EA	MORTISE CYLINDER	C887 138	626	FAL						
1	EA	SURFACE CLOSER	404XP SHCUSH	689	LCN						
1	EA	KICK PLATE	8400 10" X 2" LDW B4E	630	IVE						
1	SET	SEALS	2881AS	AL	PEM						
1	EA	DOOR SWEEP	315CN	AL	PEM						
1	EA	THRESHOLD	2727A MSES10	AL	PEM						
STOREROOM FUNCTION ALLOWED PER INTERPRETATION 10-08 DSAAC (REVISED) INSTALL HEAD SEAL BEFORE CLOSER OR HOLDER.											
Heading 2											
3	EA	HINGE	3CB14.5 X 4.5 NRP	630	IVE						
1	EA	GLASSROOM LOCK	L807L D6LL 10-072 7/8" LIP L283-150	630	SCH						
1	EA	MORTISE CYLINDER	C887 138	626	FAL						
1	EA	LOCK GUARD	LG10	630	IVE						
1	EA	SURFACE CLOSER	404XP EDA	689	LCN						
1	EA	KICK PLATE	8400 10" X 2" LDW B4E	630	IVE						
1	EA	FLOOR STOP	FS18L	BLK	IVE						
1	SET	SEALS	2881AS	AL	PEM						
1	EA	DOOR SWEEP	315CN	AL	PEM						
1	EA	THRESHOLD	2727A MSES10	AL	PEM						
INSTALL HEAD SEAL BEFORE CLOSER OR HOLDER.											
Heading 3											
3	EA	HINGE	3CB14.5 X 4.5 NRP	630	IVE						
1	EA	GLASSROOM SECURITY	L807L D6LL 10-072 7/8" LIP L283-150	630	SCH						
1	EA	MORTISE CYLINDER	C887 138	626	FAL						
1	EA	LOCK GUARD	LG10	630	IVE						
1	EA	SURFACE CLOSER	404XP EDA	689	LCN						
1	EA	KICK PLATE	8400 10" X 2" LDW B4E	630	IVE						
1	EA	FLOOR STOP	FS18L	BLK	IVE						
1	SET	SEALS	2881AS	AL	PEM						
1	EA	DOOR SWEEP	315CN	AL	PEM						
1	EA	THRESHOLD	2727A MSES10	AL	PEM						
INSTALL HEAD SEAL BEFORE CLOSER OR HOLDER.											
Heading 4											
3	EA	HINGE	3CB14.5 X 4.5 NRP	630	IVE						
1	EA	GLASSROOM SECURITY	L807L D6LL 10-072 7/8" LIP L283-150	630	SCH						
1	EA	MORTISE CYLINDER	C887 138	626	FAL						
1	EA	LOCK GUARD	LG10	630	IVE						
1	EA	SURFACE CLOSER	404XP SHCUSH	689	LCN						
1	EA	KICK PLATE	8400 10" X 2" LDW B4E	630	IVE						
1	SET	SEALS	2881AS	AL	PEM						
1	EA	DOOR SWEEP	315CN	AL	PEM						
1	EA	THRESHOLD	2727A MSES10	AL	PEM						
SEALS ARE SUPPLIED BY THE ALGL STOREFRONT MANUFACTURER.											
Heading 5											
3	EA	HINGE	3CB14.5 X 4.5 NRP	630	IVE						
1	EA	GLASSROOM LOCK	L807L D6LL 10-072 7/8" LIP L283-150	630	SCH						
1	EA	MORTISE CYLINDER	C887 138	626	FAL						
1	EA	LOCK GUARD	LG10	630	IVE						
1	EA	SURFACE CLOSER	404XP EDA	689	LCN						
1	EA	KICK PLATE	8400 10" X 2" LDW B4E	630	IVE						
1	EA	FLOOR STOP	FS18L	BLK	IVE						
1	SET	SEALS	2881AS	AL	PEM						
1	EA	DOOR SWEEP	315CN	AL	PEM						
1	EA	THRESHOLD	2727A MSES10	AL	PEM						
INSTALL HEAD SEAL BEFORE CLOSER OR HOLDER.											
Heading 6											
3	EA	HINGE	3CB14.5 X 4.5 NRP	630	IVE						
1	EA	GLASSROOM HOLD BK	L807L D6LL 10-072 7/8" LIP L283-150	630	SCH						
1	EA	PUSH PLATE	8200 8" X 16" CFC	630	IVE						
1	EA	DOOR PULL	VR800	630	IVE						
1	EA	SURFACE CLOSER	404XP EDA	689	LCN						
1	EA	KICK PLATE	8400 10" X 2" LDW B4E	630	IVE						
1	EA	FLOOR STOP	FS18L	BLK	IVE						
1	SET	SEALS	2881AS	AL	PEM						
1	EA	DOOR SWEEP	315CN	AL	PEM						
1	EA	THRESHOLD	2727A MSES10	AL	PEM						
ALL SIGNAGE BY SIGNAGE SECTION 101400 INSTALL HEAD SEAL BEFORE CLOSER OR HOLDER.											
Heading 7											
3	EA	HINGE	3CB14.5 X 4.5 NRP	630	IVE						
1	EA	GLASSROOM HOLD BK	L807L D6LL 10-072 7/8" LIP L283-150	630	SCH						
1	EA	PUSH PLATE	8200 8" X 16" CFC	630	IVE						
1	EA	DOOR PULL	VR800	630	IVE						
1	EA	SURFACE CLOSER	404XP SHCUSH	689	LCN						
1	EA	KICK PLATE	8400 10" X 2" LDW B4E	630	IVE						
1	EA	FLOOR STOP	FS18L	BLK	IVE						
1	SET	SEALS	2881AS	AL	PEM						
1	EA	DOOR SWEEP	315CN	AL	PEM						
1	EA	THRESHOLD	2727A MSES10	AL	PEM						
ALL SIGNAGE BY SIGNAGE SECTION 101400 INSTALL HEAD SEAL BEFORE CLOSER OR HOLDER.											
Heading 8											
1	EA	PAD LOCK	LICV-LFIC KS41D1200	606	SCH						
1	EA	SPIC CORE		626	FAL						
1	EA	HARDWARE	BALANCE OF HARDWARE BY DOOR SUPPLIER	BYO							

DOOR SCHEDULE AND LEGEND

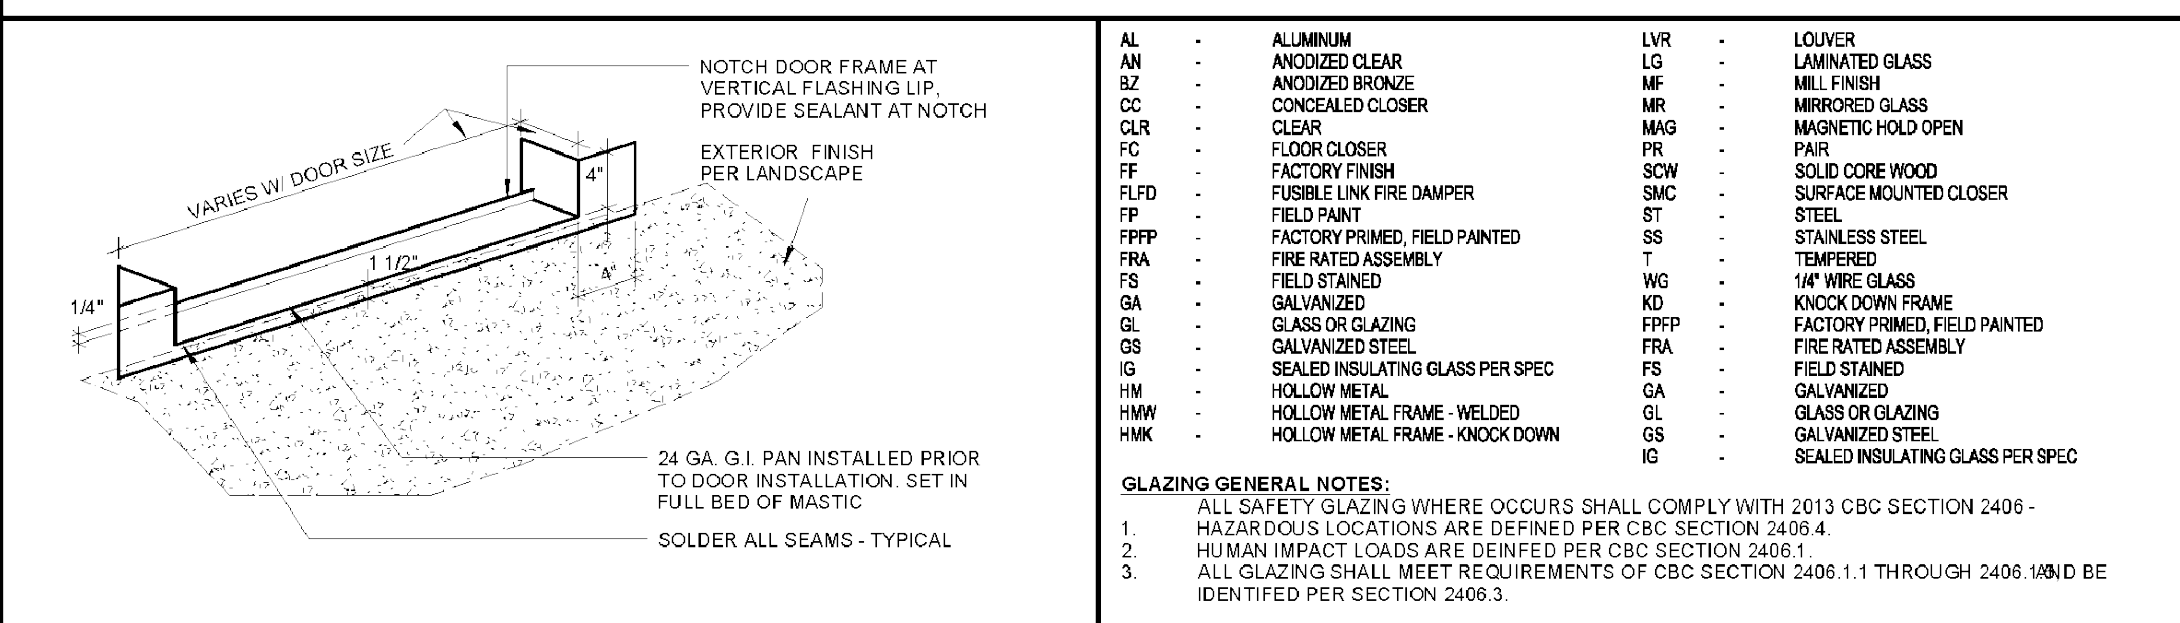

EXT. DOOR THRESHOLD FLASHING 3" = 1'-0" 8

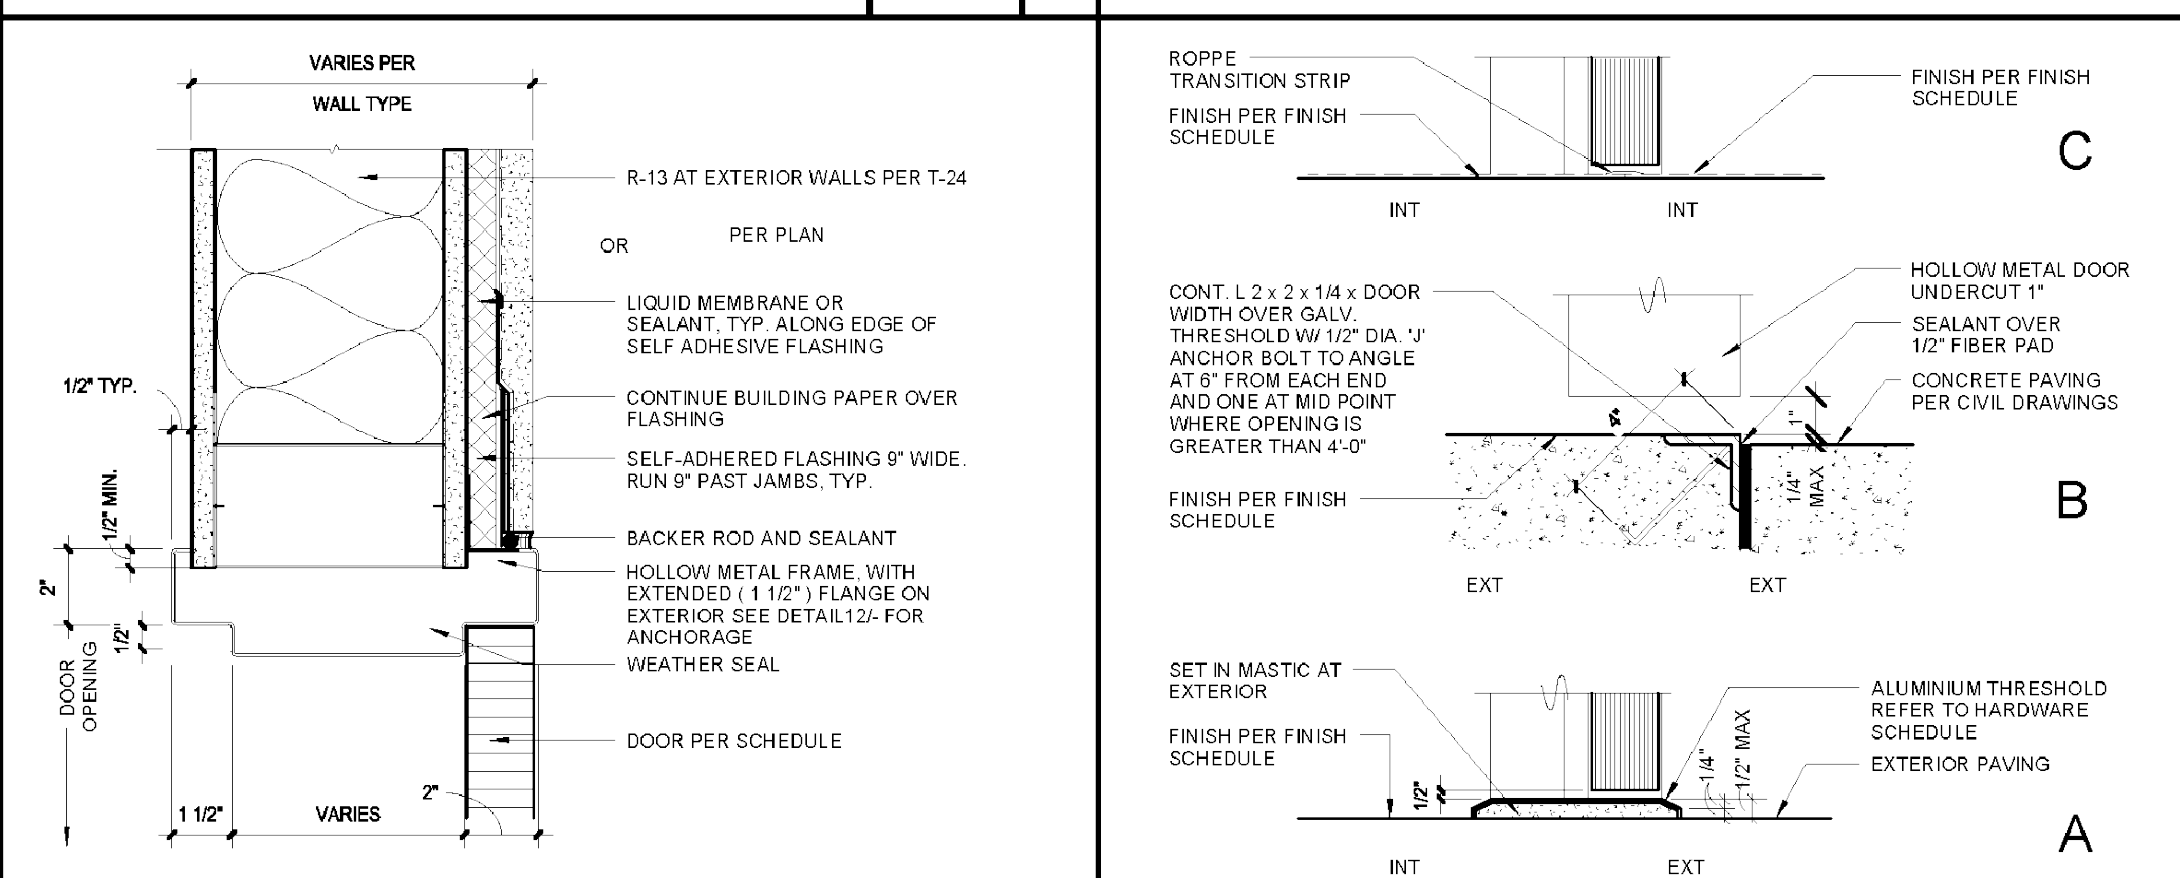

DOOR JAMB @ EXT. 3" = 1'-0" 7

THESE DRAWINGS AND ALL MATERIAL CONTAINED HEREIN ARE THE PROPERTY OF SILVERCREEK INDUSTRIES, INC (SCI Inc) AND SHALL NOT BE REPRODUCED, COPIED OR OTHERWISE DISPOSED OF DIRECTLY OR INDIRECTLY AND SHALL NOT BE USED IN WHOLE OR IN PART TO ASSIST IN THE MAKING OF OR FOR THE PURPOSE OF FURNISHING ANY INFORMATION FOR THE MAKING OF DRAWINGS, PRINTS, APPARATUS OR PARTS THEREOF WITHOUT THE FULL KNOWLEDGE AND WRITTEN CONSENT OF SCI Inc.

ALL MATERIAL CONTAINED HEREIN AND ORIGINATING WITH SCI Inc SHALL BE THE PROPERTY OF SCI Inc

SILVER CREEK INDUSTRIES, INC.

**SILVER CREEK**

Building for the Next Generation

2830 BARRETT AVE PERRIS, CALIFORNIA 92571  
PHONE: 951-943-5393 FAX: 951-943-2211

PROJECT NAME:

**EL MONTE UNIFIED SCHOOL DISTRICT**

**EL MONTE CA**

**SCI PROJECT NO. 10644**

SHEET TITLE:

**SCHEDULES**

ARCHITECT OF RECORD SUBMISSION DATE

PROJECT SPECIFIC STATE AGENCY APPROVAL

REVISIONS

ADDENDUM-A\_04 / 05 / 2017

SILVER CREEK INDUSTRIES

PROJECT NO: 10644

DRAWN BY: FIL C.

SCALE: AS NOTED